

Morris Solar Open House



WELCOME!





Accelerating the future of energy, together

- → The AES Corporation is a global energy company, with a focus in the U.S., that is accelerating the future of energy. AES has been developing and delivering innovative energy solutions to its customers for over 40 years. In the U.S. alone, AES successfully operates more than 450 solar projects that are in the ground and reliably producing clean energy across 25 states.
- → AES is a market leader in clean energy development in the U.S. AES is also a diversified energy company, owning and operating two large investor-owned utilities in Indiana and Ohio, as well as other generation assets in the U.S. and worldwide.

4.7 GW in operations

50+ GW in development






Morris Solar Project Overview

- → Nameplate Capacity: 250 MW
- \rightarrow Location: Adair County, MO
- \rightarrow Point of Interconnection: Zachary 345 kV Substation
- \rightarrow Project Footprint: ~1,100 acres
- \rightarrow Environmental Benefits: reduce CO2 emissions by ~343,000 tons per year (equivalent to powering ~36,000 homes' energy use per year)
- \rightarrow Expected Commercial Operation Date (COD): Spring 2025

Mid. Development: \rightarrow Land Acquisition

Late Development:

- → Adair County Permit Approval

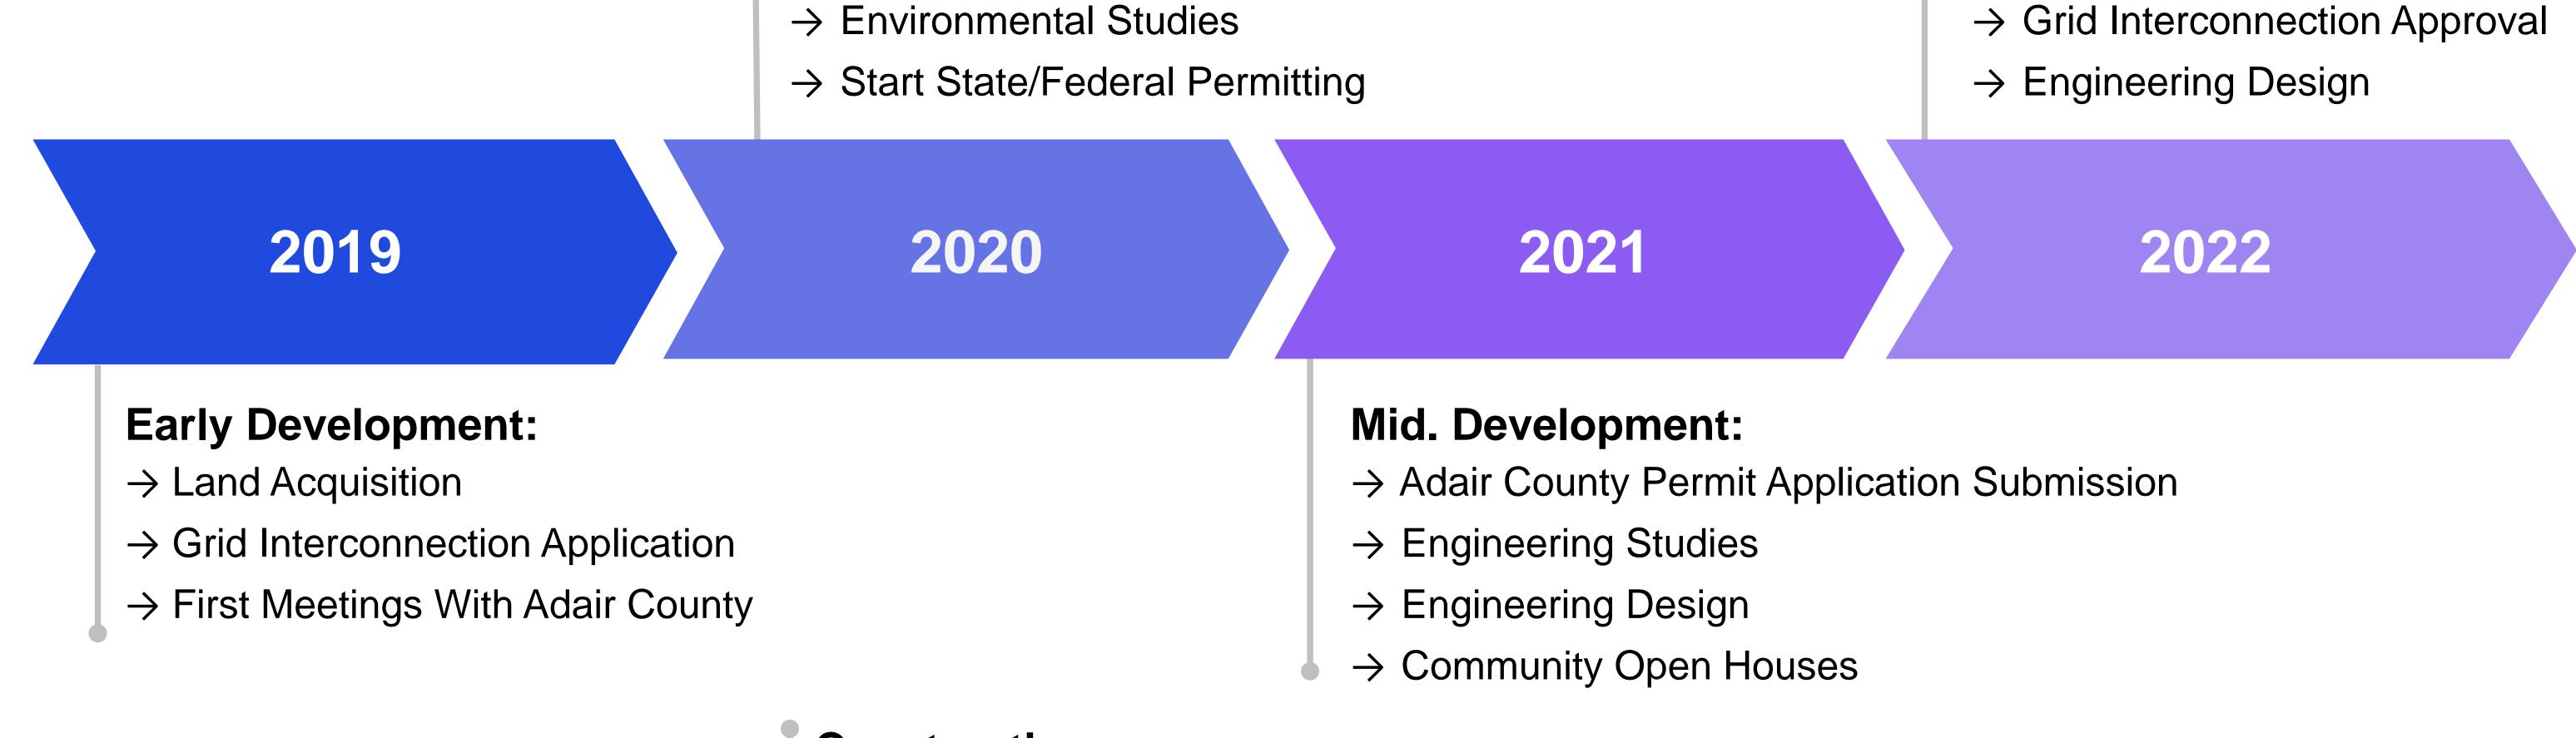

Construction:

- \rightarrow Pile Driving
- \rightarrow Mechanical Engineering
- \rightarrow Electrical Engineering
- \rightarrow Connection to the Grid





2025 & Beyond


Construction:


- \rightarrow Finish State/Federal Permitting
- \rightarrow Finalize Site Design
- → Community Open Houses
- \rightarrow Construction Mobilization Fall 2023
- \rightarrow Site Clearing
- \rightarrow Grading

Operations:

- \rightarrow Construction Ends Spring 2025
- \rightarrow Operation Begins



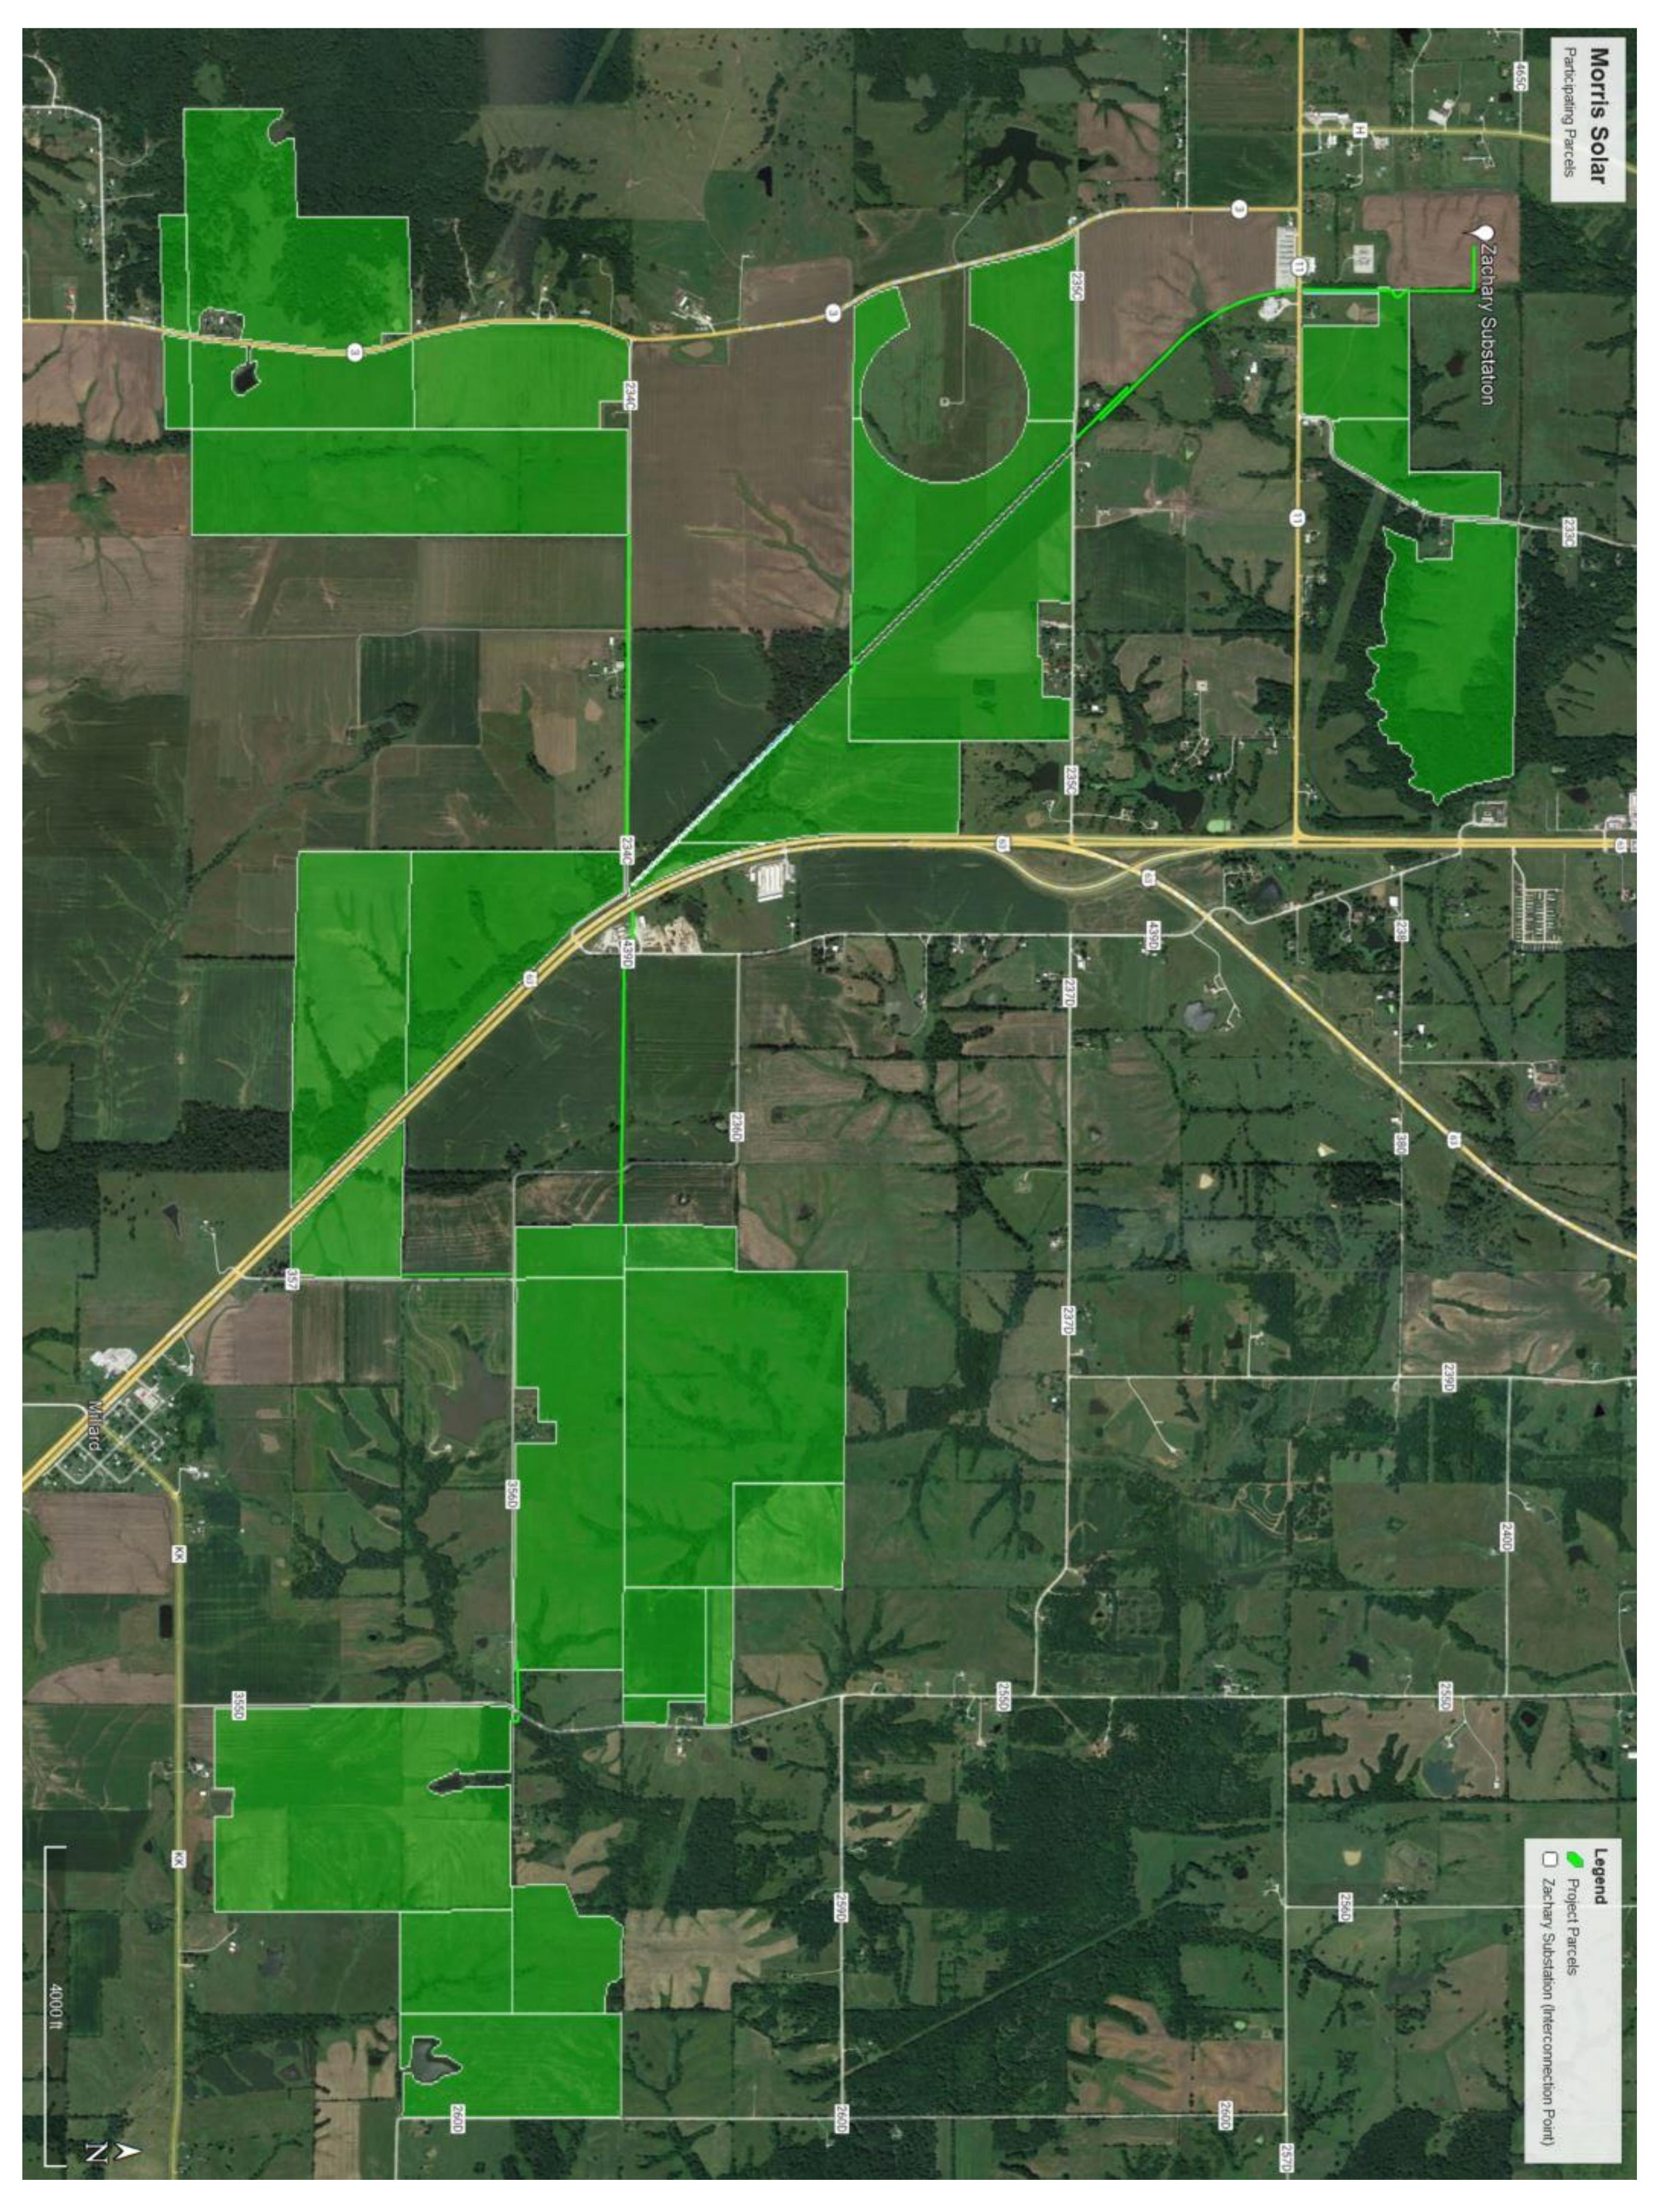

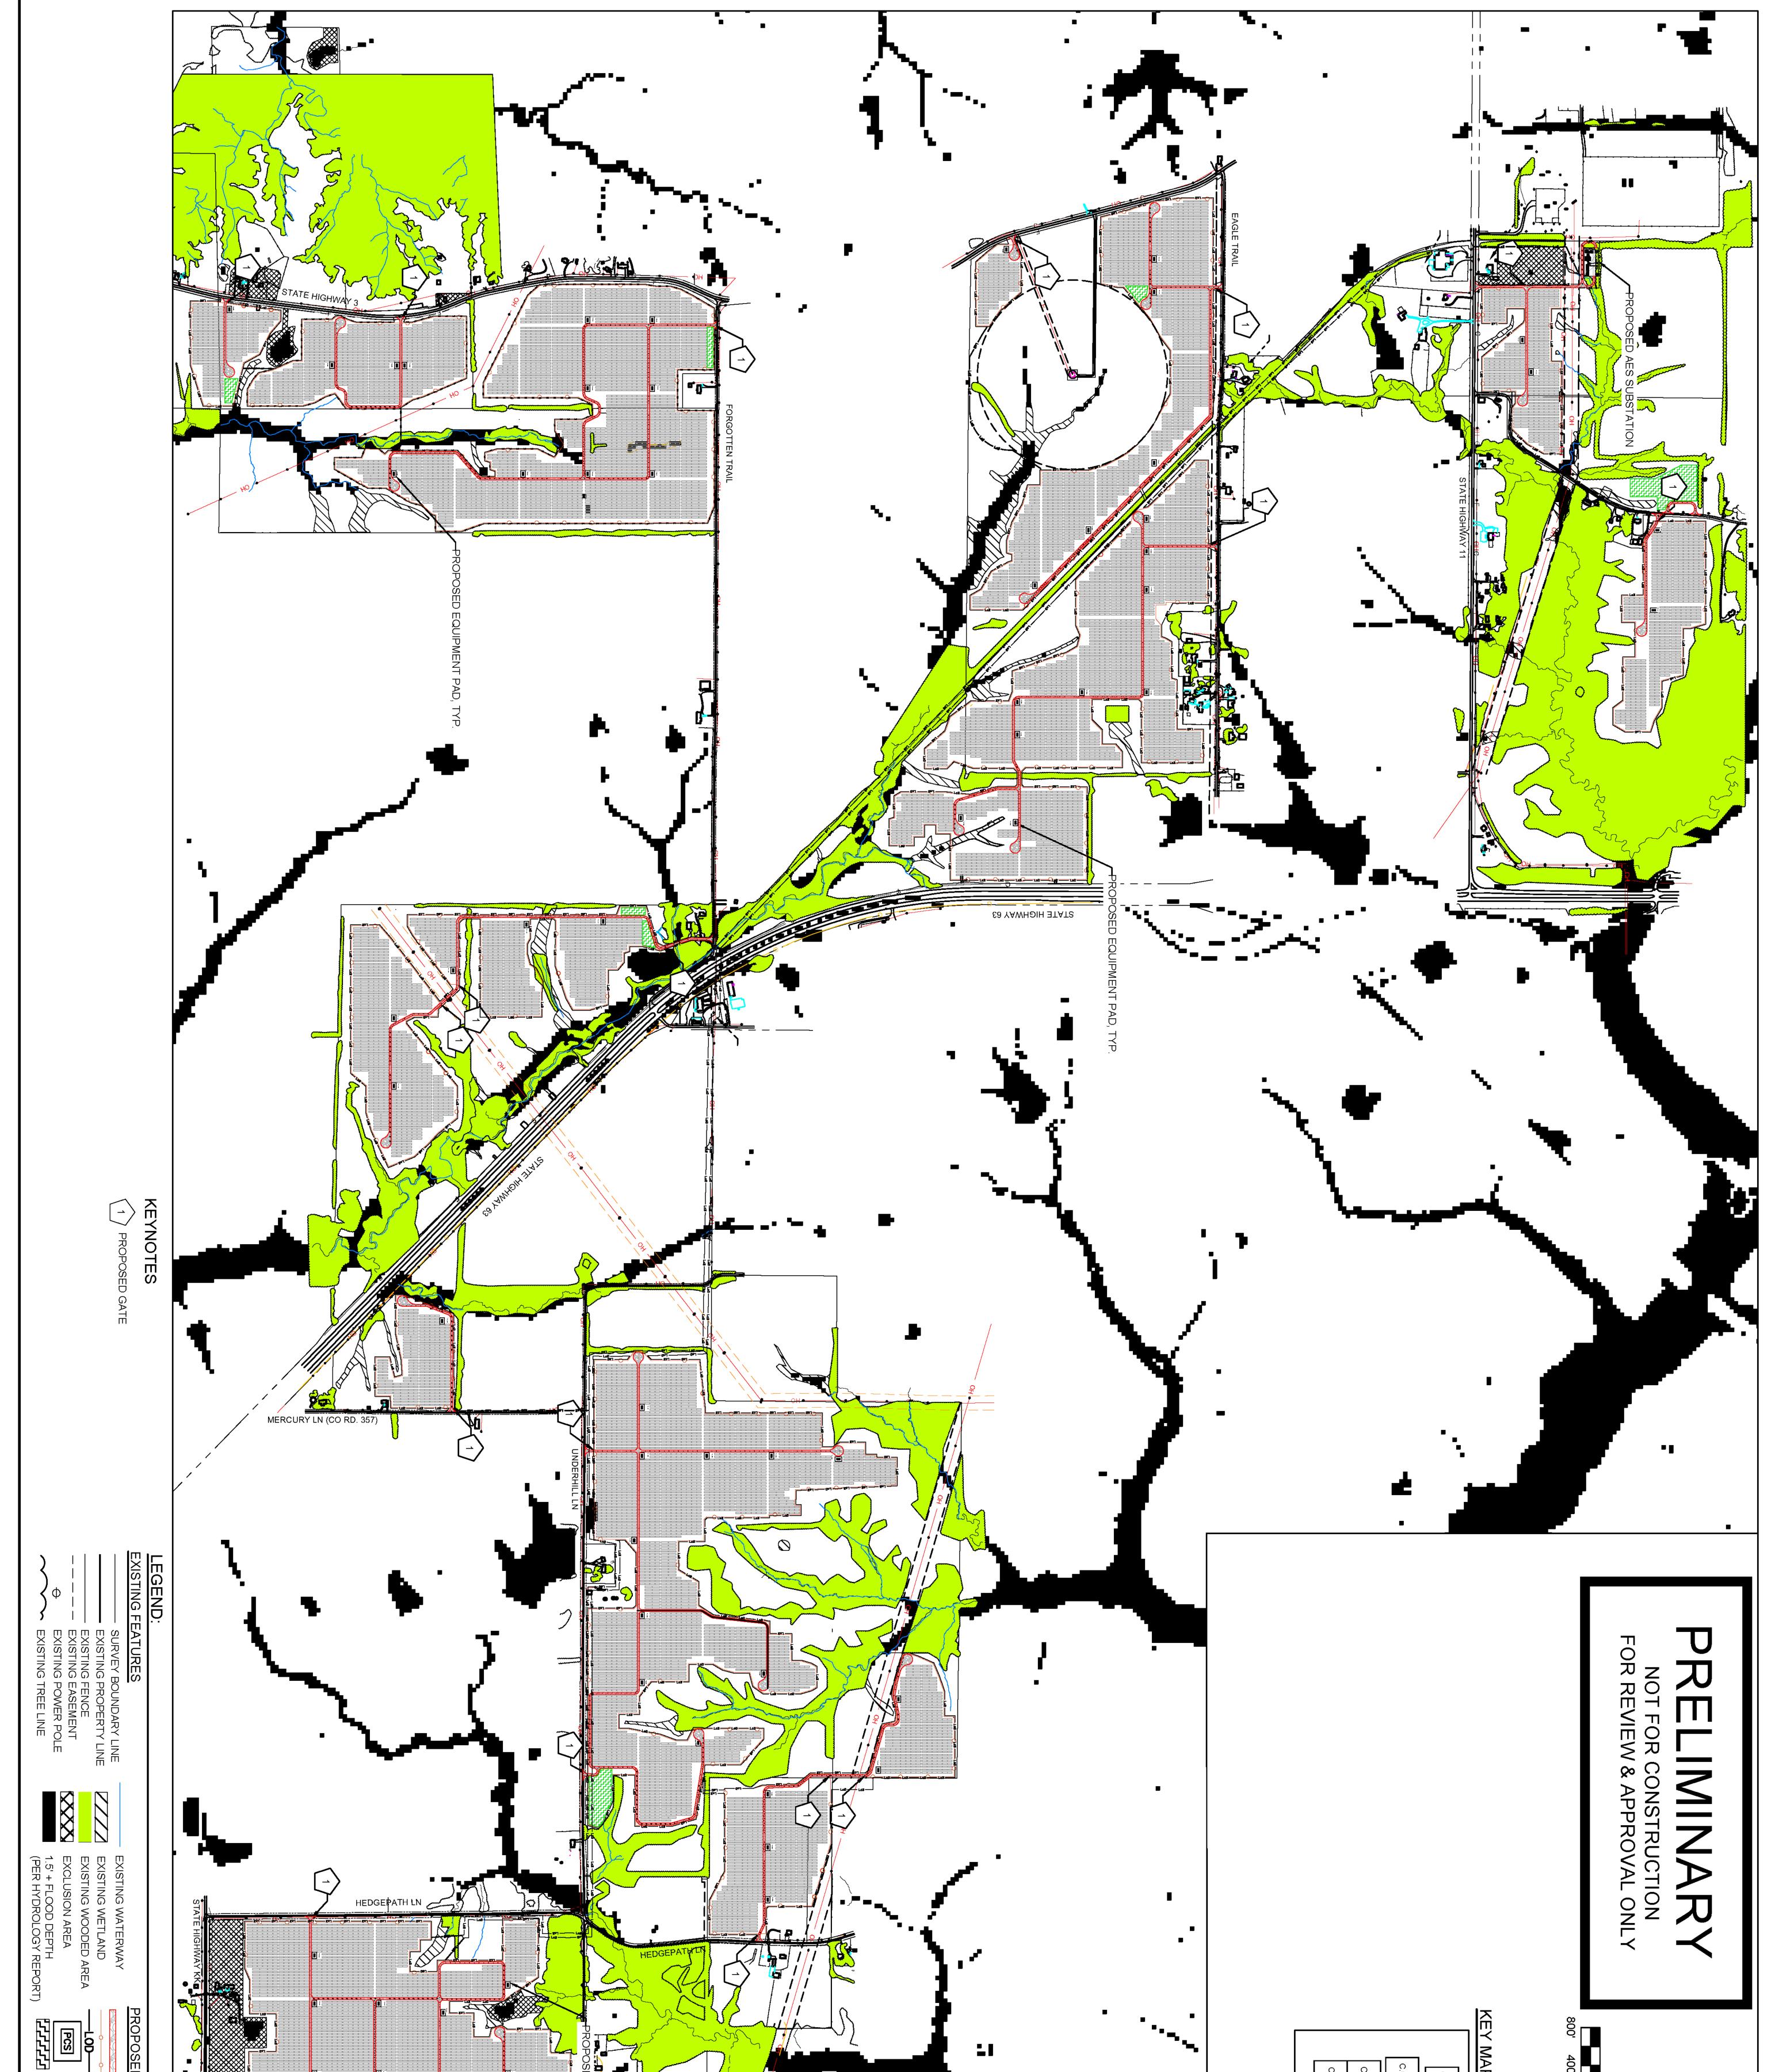

PROPOSED FEATURES PROPOSED ACCESS ROAD PROPOSED SECURITY FENCE PROPOSED DISTURBANCE LIMITS PROPOSED EQUIPMENT PAD PROPOSED CONSTRUCTION LAYDOWN AREA	ROPOSED EQUIPMENT PAD, TYP.		C.03.03 C.03.04 C.03.05 C.03.06 C.03.07 C.03.08 C.03.10 C.03.12 C.03.11 C.03.12 C.03.11 C.03.12	Y 400' 0 800' 1600' 2400' SCALE: 1"=800' 2400'
OVERALL CIVIL SITE PLAN PROJ NUM: 3846.001 DES: VC DWN: VC CHK: RB APV: RB DATE: 7-6-22 SCALE AT 24" X 36": 1" = 800' SHEET NO: PV-C.03.01 REET NO: REV	PROJECT LOCATION: ADAIR COUNTY, MO SHEET TITLE & DESCRIPTION: PV CIVIL	REVISIONS: NO. DATE DESCRIPTION A 5-24-22 ISSUE FOR REVIEW B 7-6-22 ISSUED FOR REVISION	KEY PLAN:	2180 South 1300 East, Suite 600 Salt Lake City, UT 84106-2749 (801) 679 - 3500

Community

Benefit





- \rightarrow AES is committed to strengthening positive impact through mutually beneficial partnerships in the communities where we work
- \rightarrow Our focus pillars include the following:
 - \rightarrow Partnering for access to safe, efficient, and affordable energy and basic services
 - \rightarrow Partnering for Inclusive Economic Growth & Education
 - \rightarrow Partnering for the Environment
 - → Partnering for Community Health & Well-Being



- \rightarrow \$385 million in capital investment
- \rightarrow \$8.8 million in estimated tax over 35 years of operation to Adair County and the Kirksville R-III School District
- \rightarrow 340+ jobs during construction
- \rightarrow 6-10 full-time equivalent jobs

- \rightarrow Supporting local businesses including restaurants, food trucks, convenience stores, construction equipment, building materials and lodging.
- \rightarrow Project does not require additional County or City services, so no pressure on local services/resources

For more information, please contact stakeholderrelations@aes.com



Environmental Studies & Agency

Coordination



Federal

- → Nationwide Permit from U.S. Army Corps of Engineers
- → Section 7 Consultation with U.S. Fish and Wildlife Service for Incidental Take Permit

Local

- Ordinance with Adair County Ordinances
 Ordinances
- → Road Maintenance & Use Agreement
- A Right-of-Way & Encroachment Agreement
- → Coordination with Emergency Services

State

- → State Historic Preservation Office
- → Missouri Dept. Of Natural Resources

Environmental & Technical Studies

- → Critical Issues Analysis (July 2020)
- → Raptor Nest Survey (April 2021)
- → Desktop Cultural Resources Study (May 2021)
- → Bat Habitat Suitability Assessment (July 2021)
- → Mead's Milkweed Survey (September 2021)
- → Geotechnical Report (March 2022)
- → Wetland Delineation (May 2022)
- → Phase 1 Cultural Resources Survey (October 2022)
- → Phase 1 Environmental Site Assessment (December 2022)



Solar Construction



Safety

- \rightarrow At AES, we put safety first and it is our top core value
- → There are not any peer-reviewed reports of solar panels causing health and safety issues
- → Solar systems are governed by the same Building/Electrical/Fire codes that govern the construction of homes and other buildings in the community

Impacts


- → During development, impact studies are done to identify sensitive features of the project area so that we can construct the facility in a way that avoids any impacts to the environment
- \rightarrow The project will not impact stormwater runoff outside of the project area
- → Once the project is built, it will be AES' financial and contractual obligation to restore county roads and bridges to their pre-construction condition

Process

- \rightarrow The entire construction period of this project is expected to last approximately 19 months
- → Construction will only take place during appropriate work hours
- \rightarrow Early on in construction, pile driving will take place and cause some noise over the course
- of roughly 2 months
- \rightarrow During the process of construction, nearby residents can expect
 - →Minor increase in traffic on designated roads
 - \rightarrow Potential dust during pile driving
 - \rightarrow Larger trucks on haul roads during construction hours.
 - \rightarrow Once construction is over, the project will be a quiet neighbor and
 - traffic will return to normal



Solar Operations

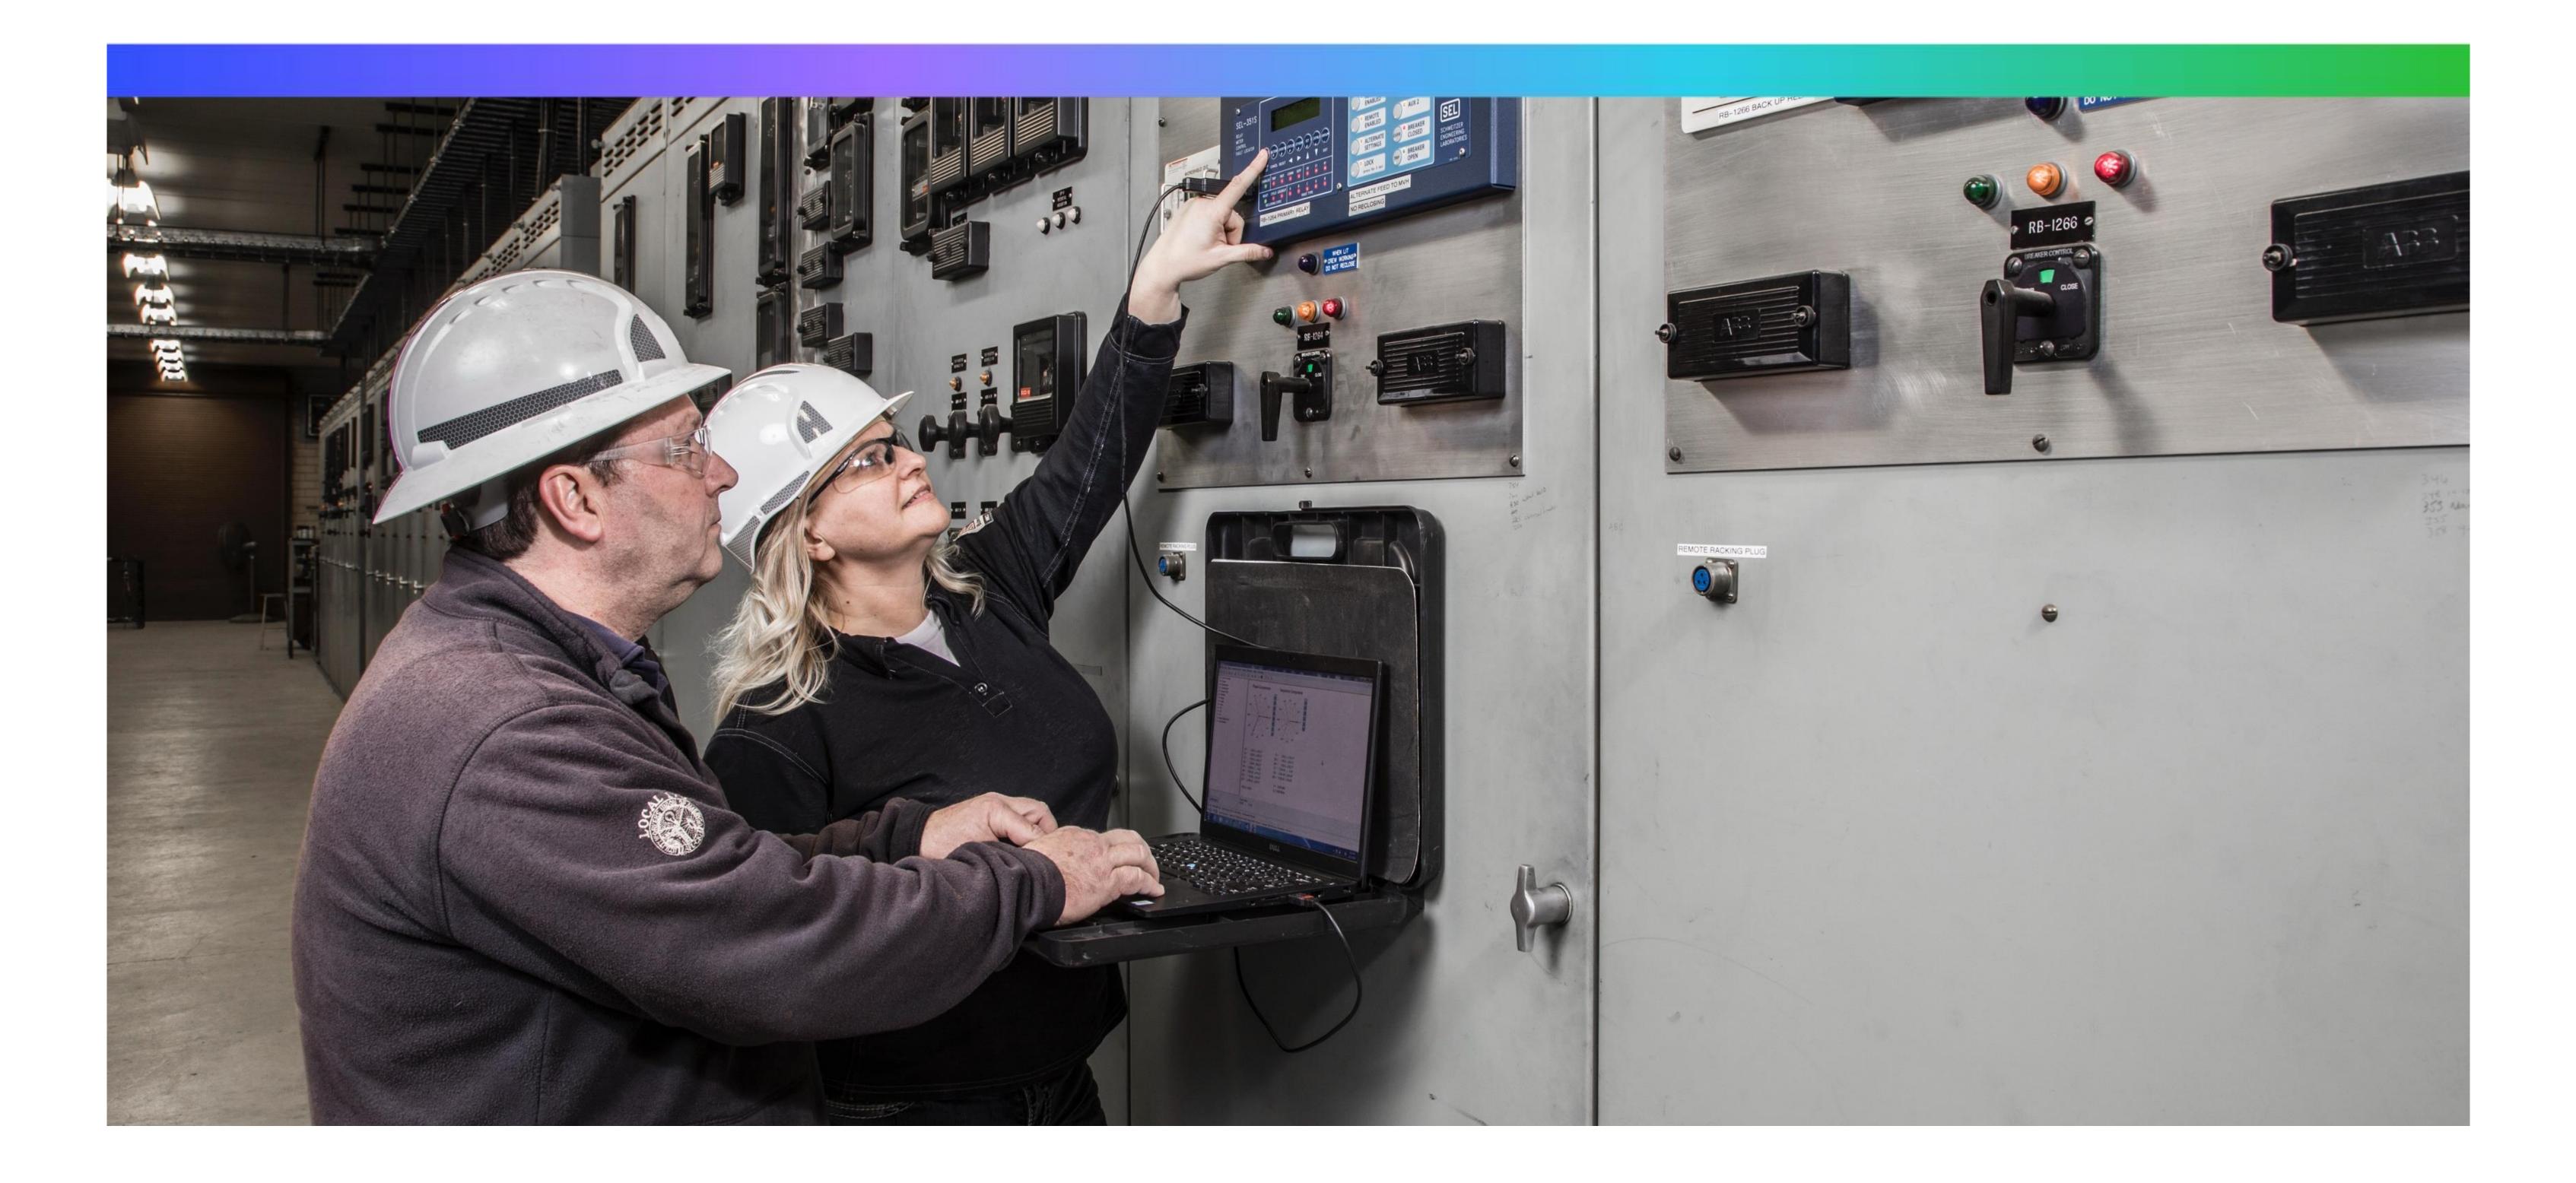

Monitoring

- \rightarrow 24-7 / 365 days a year remote monitoring
- → Supervisory control and data acquisition (SCADA) system

Maintenance

- \rightarrow Minimal annual maintenance will be required
- \rightarrow AES will regularly inspect project site to ensure all components are operating properly
- \rightarrow AES construction and operations team will be on-call in the event of a maintenance issue
- → AES typically contracts with a local landscaping company to provide services including any vegetative buffers to assist with viewshed

Security

- \rightarrow Project sites will be fenced off with strict, electronically controlled security access gates
- \rightarrow Securely installed enclosed electrical equipment will be on-site
- \rightarrow Local fire & rescue will have access to the site as needed

